


SEQUENCE OF OPERATION:

- 1. INSTALL PUMP DISCHARGE PIPE ACROSS ROUTE 30 AND SET UP BYPASS PUMP
- 2. INSTALL SHEET PILE COFFERDAM AND EXISTING CULVERT PIPE EXTENSIONS
- 3. INSTALL ROADWAY SUPORT GRAVELS

NOTES:


THE INTENT OF THE STREAM DIVERSION IS TO UTILIZE THE EXISTING CULVERTS DURING THE CULVERT INSTALLATION. THE COFFER DAM WILL BUILD A WATER LEVEL ENOUGH FOR THE PUMP SUCTION TO ADAQUATLY DRAW FROM. THE SHEETS DRIVEN LOWER IN FRONT OF THE EXISTING CULVERTS IS TO ALLOW A RELIEF FOR THE STREAM TO FLOOD IF THE PUMP SHOULD BE OVER COME DURING A STORM EVENT. IF THE WATER SHOULD OVER TOP THE COFFER DAM IT WILL FLOW DOWN THE EXISTING CULVERT AS IT NORMALLY WOULD. WHEN WE HAVE SECTIONS OF THE NEW BOX INSTALLED THE EXISTING CULVERTS WILL BE MADE TO EXTEND INTO THE NEW CULVERT SO THE STREAM CAN CONTINUE ITS FLOW UNINTERUPTED.

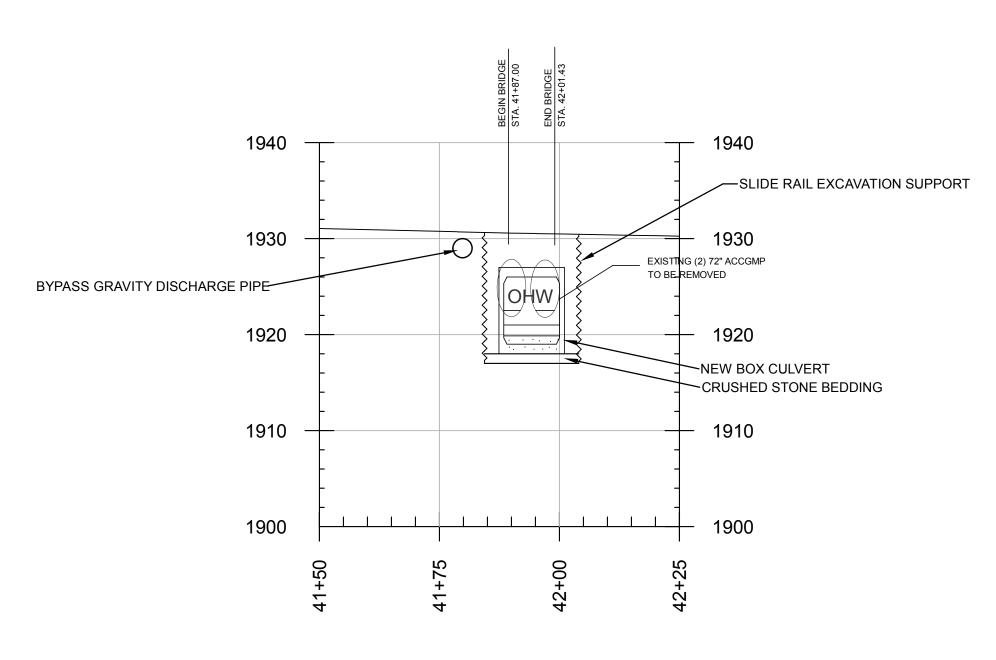


STREAM BYPASS SECTION


HORIZONTAL SCALE: 1' = 20' VERTICAL SCALE: 1" = 10'

	SHEET NAME: BR 52 STREAM DIVERSION PROFILE AND SECTION
REV. NO. DATE:	PROJECT NAME: WINHALL SHEET NO.
ENAUD BROS. INC.	PROJECT NO: STP CULV (31)
283 FT. BRIDGEMAN RD. VERNON VT., 05354 PH. (802) 257-7383 FAX:(802) 257-7308	DRAWN BY: CHK'D BY: DATE: 4

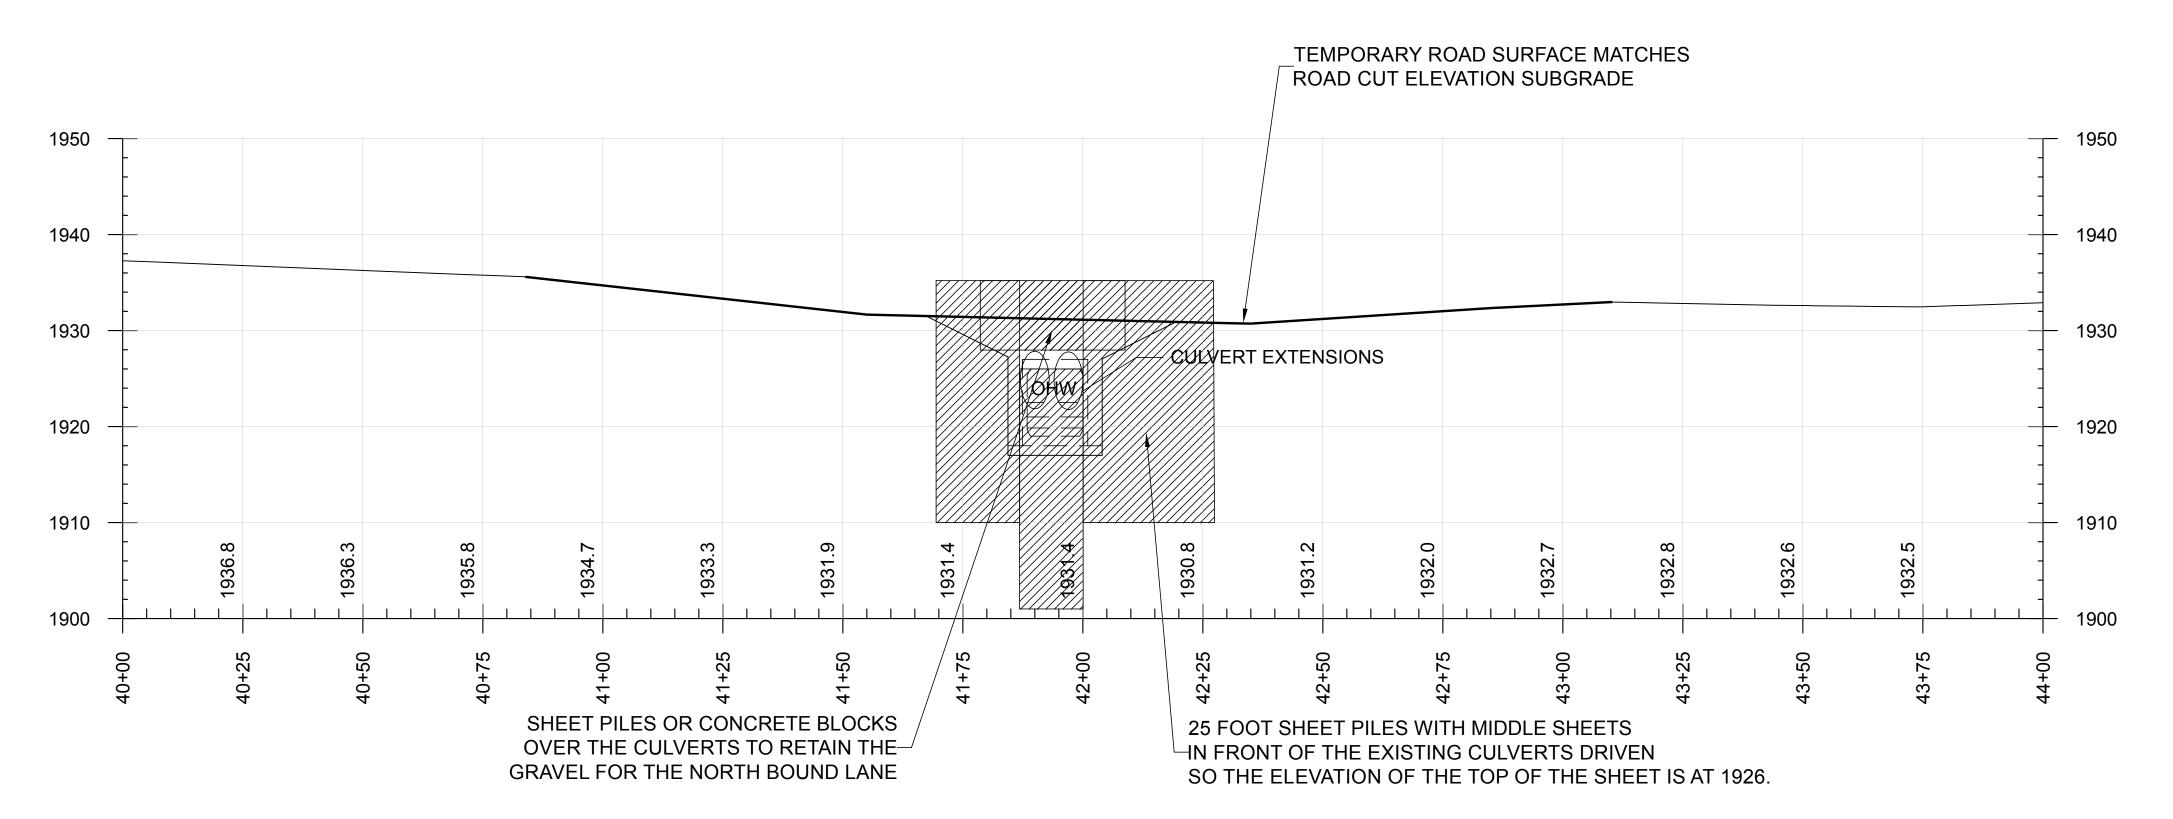

BRIDGE 52 STREAM DIVERSION COFFER DAM ELEVATION
HORIZONTAL SCALE 1" = 20'-0" VERTICAL SCALE 1" = 10'-0"

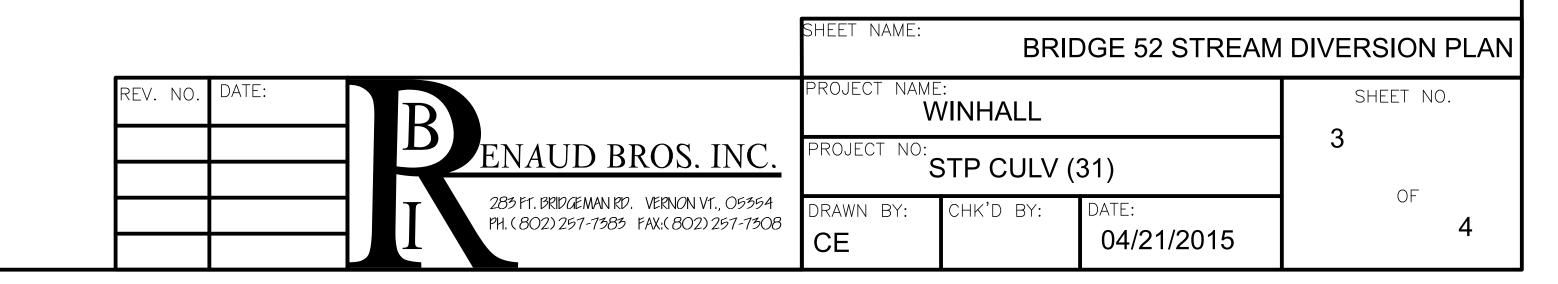

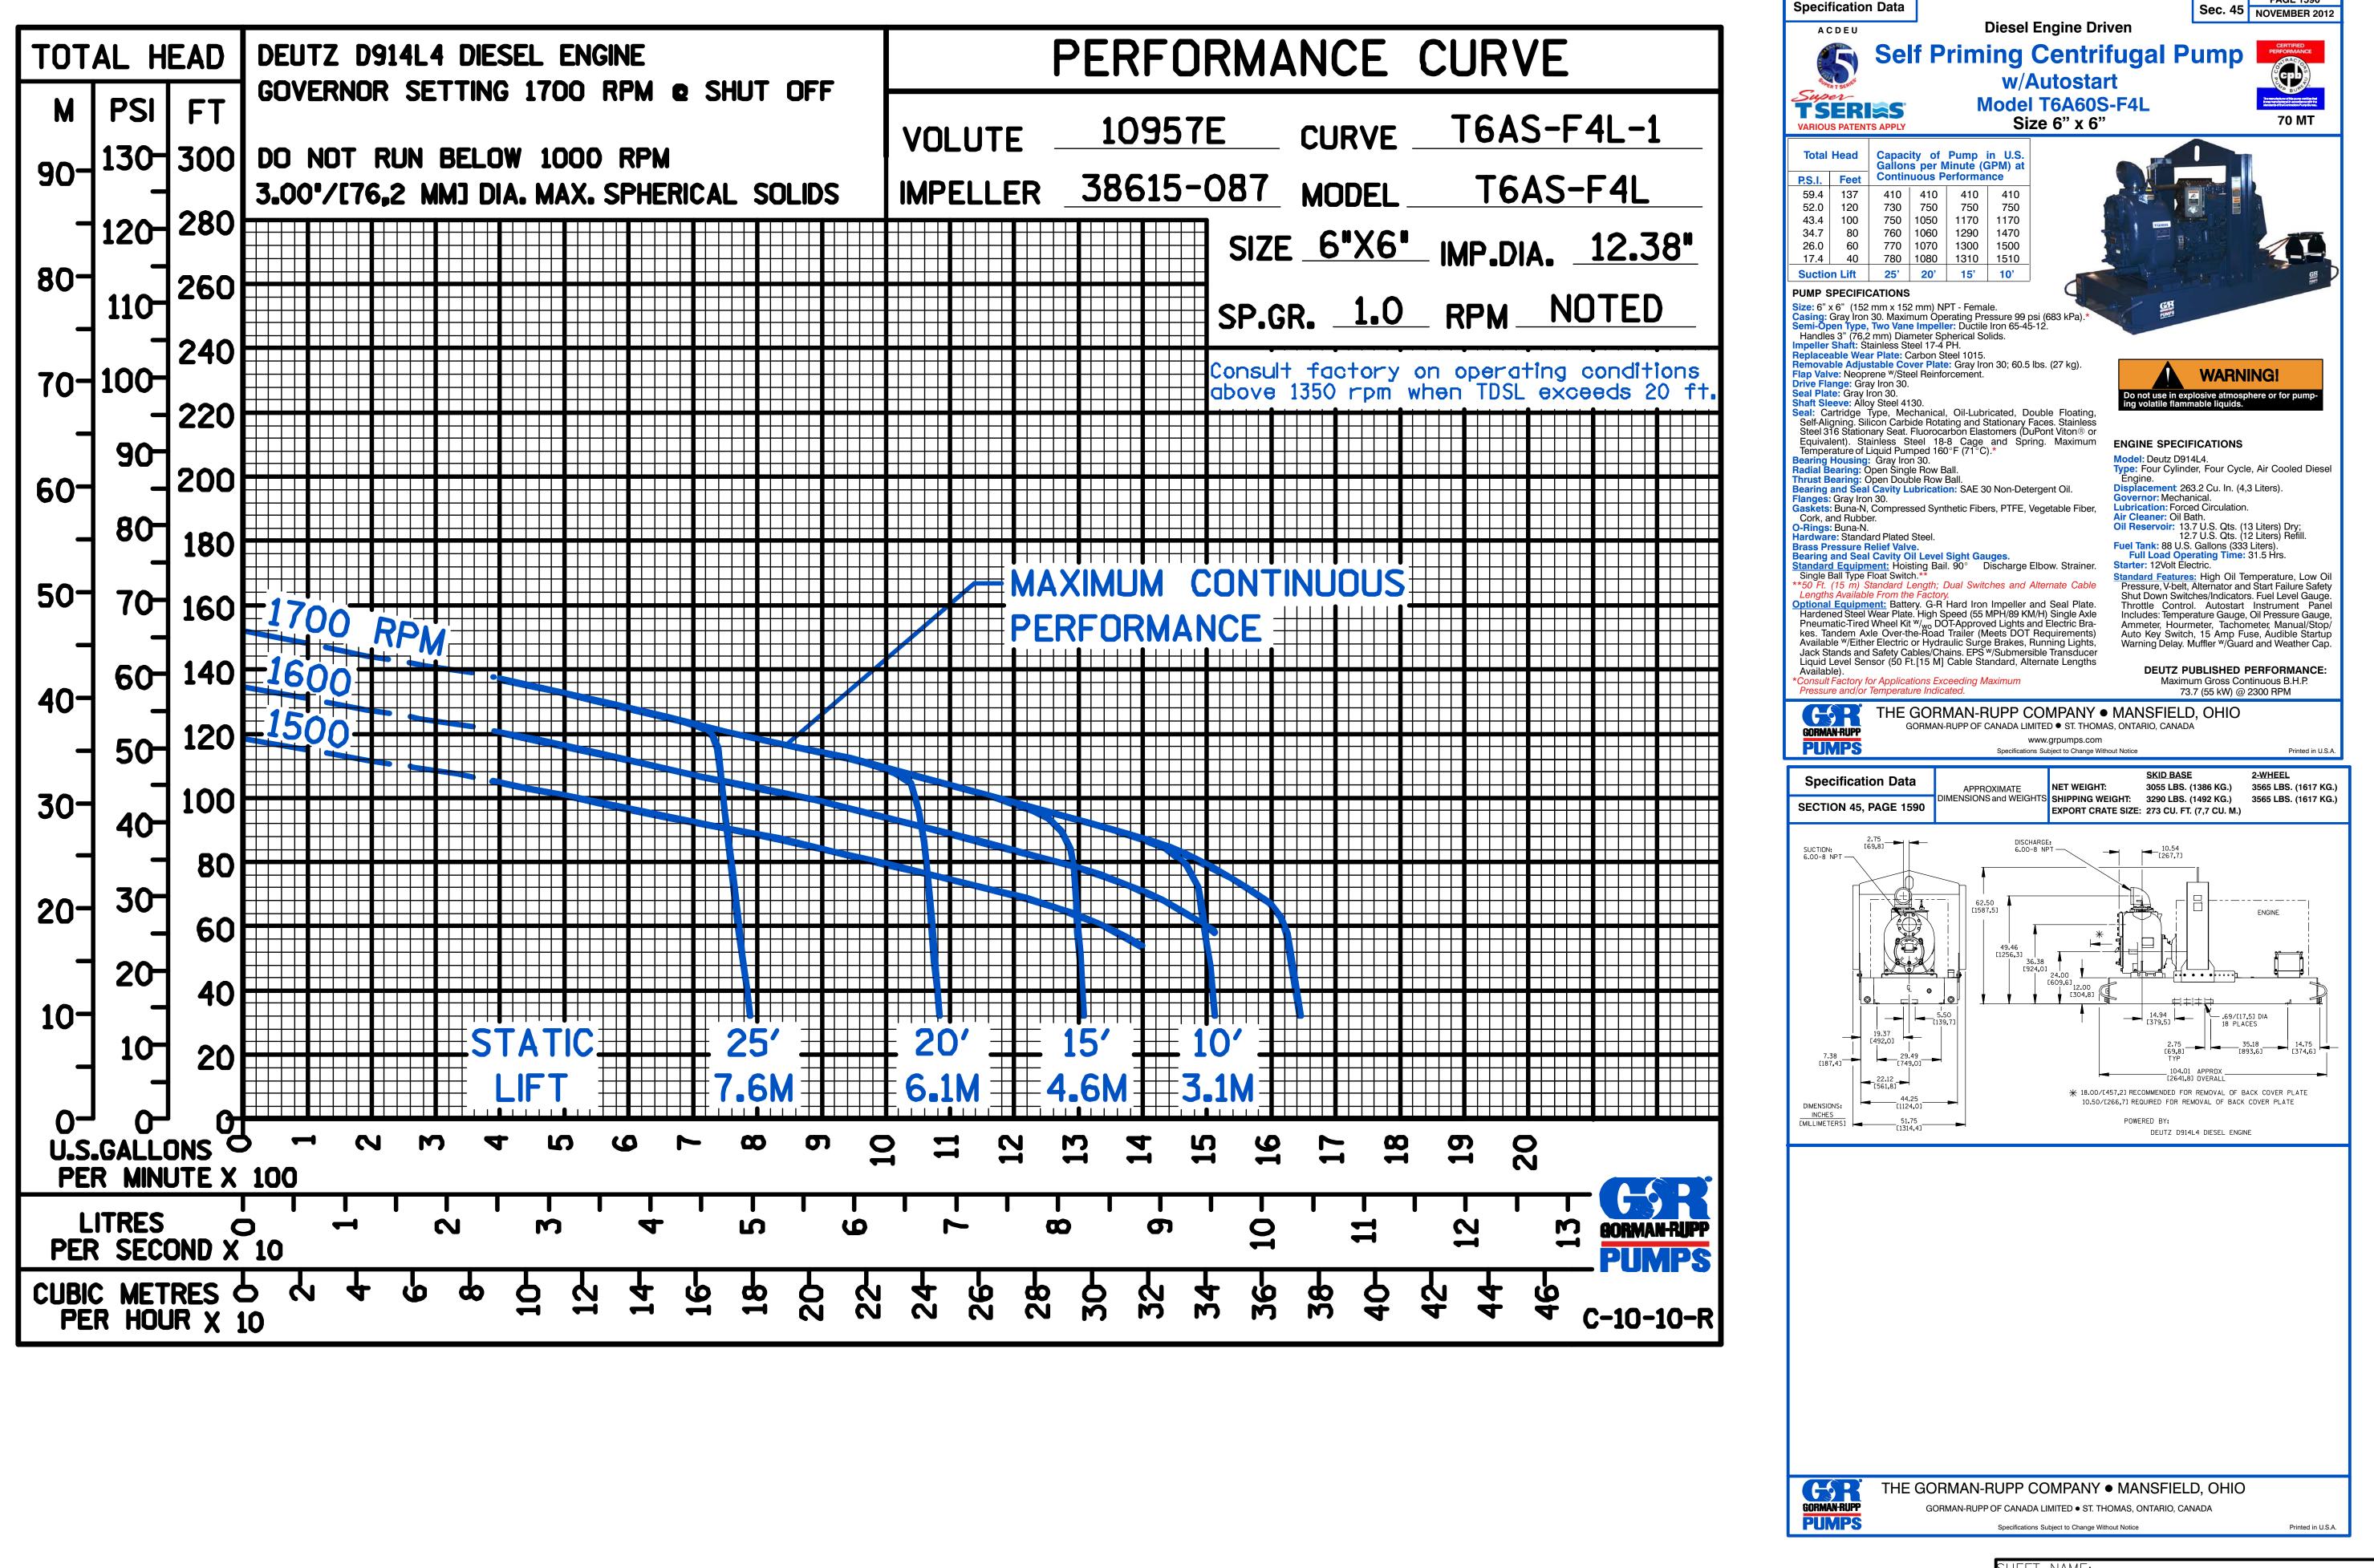

BRIDGE 52 STREAM DIVERSION PLAN

BRIDGE 52 STREAM DIVERSION PLAN

BRIDGE 52 STREAM DIVERSION PLAN

SHEET NO.

4

PROJECT NAME:
WINHALL

PROJECT NO:
STP CULV (31)

DRAWN BY:
CE

CE

DATE:
05/11/2015

From: McIntosh, Mindon (Buffalo) [mindon.mcintosh@aecom.com]

Sent: Monday-May 04-2015 3-36 PM

To: cezequelle@gmail.com; renaudbr@sover.net
Cc: ron.lemaire@state.vt.us; acentofranchi@eivtech.com
Subject: FW: Winhall STP CULV(31) Water Diversion Plan Submittal

Mindon C. McIntosh NICET IV NETTCP Soils & Aggregates ACI D #518.688.0015 C #518.930.8094 mindon.mcintosh@aecom.com

AECOM 3 Corporate Drive Suite 203 Clifton Park, NY 12065

www.aecom.com

From: Lemaire, Ron [Ron.Lemaire@state.vt.us]

Sent: Friday, May 01, 2015 2:34 PM

To: McIntosh, Mindon (Buffalo); acentofranchi@eivtech.com

Subject: FW: Winhall STP CULV(31) Water Diversion Plan Submittal

From: Jacqueline Dagesse [mailto:jdagesse@eivtech.com]

Sent: Wednesday, April 29, 2015 7:20 PM

To: Lemaire, Ron

Cc: Farley, William; Mackintosh, Mark

Subject: Winhall STP CULV(31) Water Diversion Plan Submittal

Hi Ron,

We completed a cursory review of the Winhall STP CULV (31) Water Diversion Plan and have the following comments:

- Renaud Brothers mentions using a 6" pump for dewatering. What size event would this pump be able to handle?
- Where are they dewatering to? Using a filter bag? What is the backup plan?
- The plansheets that they provide need to have resource information, stationing and north arrow.
- We need a more detailed description of what they plan to do.

Jacquie

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